

#### LEGEND EXISTING FEATURES PROPOSED WORKS PROPERTY BOUNDARY DESIGN CENTRELINE ----- SURFACE CONTOUR -14.6------ FINISHED SURFACE CONTOUR \_\_\_\_\_ BATTER FENCE WATERMAIN/VALVE COMMS LINE/PIT OVERHEAD POWER LINES/POWER POLE \_0\_ EXISTING ROAD SIGN

## GENERIC INSTALLATION SEQUENCE

THE FOLLOWING TABLE INDICATES MINIMUM EROSION AND SEDIMENT CONTROL MEASURES FOR THE WORKS. SITE CONDITIONS, SUCH AS THE PRESENCE OF DISPERSIVE SOLES, MAY WARRANT HIGHER EROSION AND SEDIMENT CONTROL STANDARDS. MARK OUT INITIAL LIMITS OF DISTURBANCE AND IDENTIFY LOCATION OF DISPERSIVE SOIL (IF ANY). IF DISPERSIVE SOIL IS ENCOUNTERED, CONTACT THE ESCP DESIGNER PRIOR TO COMMENCING WORKS.

ITEM INSTALLED		REMOVED	
ENTRY/EXIT ROCK PAD	PRIOR OR IN CONJUNCTION WITH SITE CLEARING.	ONCE SITE IS STABILISED AND ALL TEMPORARY FACILITIES HAVE BEEN REMOVED.	
DIVERSION CHANNELS/BERMS	PRIOR OR IN CONJUNCTION WITH SITE CLEARING.	ONCE SITE IS STABILISED AND ALL TEMPORARY FACILITIES HAVE BEEN REMOVED.	
MULCH BERMS IMMEDIATELY FOLLOWING CLEARING OF SITE AND MULCHING OF CLEARED VEGETATION		ONCE SITE IS STABILISED AND ALL TEMPORARY FACILITIES HAVE BEEN REMOVED.	
SEDIMENT FENCE	PRIOR OR IN CONJUNCTION WITH SITE CLEARING.	ONCE SITE IS STABILISED AND ALL TEMPORARY FACILITIES HAVE BEEN REMOVED.	
ROCK CHECK DAMS	INSTALLED WITHIN OPEN DRAINS IMMEDIATELY FOLLOWING EXCAVATION.	REMOVED ONCE DRAINS ARE DECOMMISSIONED OR ALTERNATIVE METHODS OF EROSION CONTROL ARE ESTABLISHED WITHIN THE DRAINS (E.G. GEOTEXTILE FABRIC OR GRASS ESTABLISHMENT)	
ROCK FILTER DAMS	INSTALLED WITHIN OPEN DRAINS IMMEDIATELY FOLLOWING EXCAVATION.	ONCE SITE IS STABILISED AND ALL TEMPORARY FACILITIES HAVE BEEN REMOVED.	
REVEGETATION	PROGRESSIVELY AS GROUND DISTURBANCE ACTIVITIES ARE COMPLETED.	N/A	
STC HUMECEPTER	INSTALLED WITHIN OPEN DRAINS IMMEDIATELY FOLLOWING EXCAVATION.	N/A	

STAGING OF WORKS				
ITEM OF WORKS	TIMING SCHEDULE			
SITE INFRASTRUCTURE INSTALLATION	OCT 2023 – TBC			
REHABILITATION	PROGRESSIVE			

## **EROSION RISK ASSESSMENT**

CATCHMENT	AREA (ha)	R	K	LS	Р	C	A (t/ha/month)	A (t/month)	CONTROL
(A) - LOT 1-7,12	0.38*	4496	0.027	0.19	1.3	0.4	12	5	TYPE 2
<b>(B)</b> –LOT 8–11, 13	0.38*	4496	0.027	0.19	1.3	0.4	12	5	TYPE 2
CARPARK	0.56	4496	0.027	0.19	1.3	0.4	12	7	TYPE 2
LAYDOWN	1.0	4496	0.027	0.24	1.3	0.3	11	11	TYPE 2
<b>(C)</b> -SITE ROAD - NORTH (W)	0.25	4496	0.027	0.31	1.3	0.80	39	10	TYPE 2
(D) - SITE ROAD - WEST	1.86	4496	0.027	0.31	1.3	0.10	5	9	TYPE 3
(E) -SITE ROAD - EAST	0.72	4496	0.027	0.41	1.3	0.10	6	5	TYPE 2
<b>(F)</b> -SITE ROAD - NORTH (E)	0.46	4496	0.027	0.41	1.3	0.32	12	5	TYPE 2

### \* AREA OF INDIVIDUAL LOTS

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LATITUDE 63

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GENERAL ARRANGEMENT

	NOT TO SCALE				
	SCHEDULE OF DRAWINGS				
DRAWING NO.	DRAWING NO. CONSTRUCTION DRAWINGS				
ESC100	2023/24 WET SEASON ESCP - COVER SHEET				
ESC101	2023/24 - NOTES				
ESC102	2023/24 - WET SEASON WROKS (OCTOBER TO APRIL 2024)				
ESC200	2023/24 - MARINE PIPELINE GENERAL ARRANGEMENT				
ESC201	2023/34 – MARINE PIPELINE WET SEASON ESCP				
ESC202	2023/34 - MARINE PIPELINE TRENCHING STANDARD CONTROLS				
	STANDARD DRAWINGS				
	IECA STANDARD DRAWINGS – DRAINAGE CONTROLS				
ECM-01	EROSION CONTROL MATS				
ES-1	EMERGENCY SPILLWAYS				
TCC-01	TEMPORARY CULVERT CROSSING PART 1				
TCC-02	TEMPORARY CULVERT CROSSING PART 2				
RCD-01	CHECK DAMS				
DB-01	FLOW DIVERSION BANKS				
	IECA STANDARD DRAWINGS - EROSION CONTROLS				
GRAVEL-01	GRAVELLING				
R-01	REVEGETATION - GENERAL				
	IECA STANDARD DRAWINGS – SEDIMENT CONTROLS				
EXIT-01	CONSTRUCTION EXIT - ROCK PAD				
MB-01	MULCH FILTER BERMS				
SF-01	SEDIMENT FENCE				
SF-02	SEDIMENT FENCE NOTES				
RFD-03	ROCK FILTER DAM (INSTREAM)				
	IECA DEWATERING				
GFB-01	GRASS FILTER BEDS				
FB-01	FILTER BAGS AND FILTER TUBES				
\./					

## WARNING

BEWARE OF UNDERGROUND SERVICES The locations of underground services are approximate only

and their exact position should be proven on site No guarantee is given that all existing services are shown

AMENDME

14/09/23 PB ISSUED FOR REVIEW

No DATE INITIAL

# ISSUED FOR CONSTRUCTION

## **GENERAL NOTES**

- 1. THIS IS A 'WET SEASON' ESCP. NOTE THAT IN THE TOP END OF THE NORTHERN TERRITORY, EARTHWORKS ARE CONSIDERED HIGHER RISK DURING THE WET SEASON MONTHS (OCTOBER TO APRIL OF EACH YEAR) AND GREATER CONTROLS ARE REQUIRED DURING THIS TIME.
- 2. FOLLOWING THE 2023/24 WET SEASON (APRIL 2024), A REVISED EROSION AND SEDIMENT CONTROL PLAN (ESCP) SHALL BE SUBMITTED FOR APPROVAL TO DEPWS AND ADDITIONAL EROSION AND SEDIMENT CONTROL MEASURES SHALL BE IMPLEMENTED.
- 3. ALL WORKS SHALL BE UNDERTAKEN IN ACCORDANCE WITH THE APPROVED ESCP AND ASSOCIATED DEVELOPMENT CONDITIONS.
- 4. EROSION AND SEDIMENT CONTROL MEASURES SHALL CONFORM TO THE STANDARDS AND SPECIFICATIONS CONTAINED IN
- A.THE APPROVED ESCP AND SUPPORTING DOCUMENTATION; AND
- B. THE LATEST VERSION OF INTERNATIONAL EROSION CONTROL ASSOCIATION (IECA) GUIDELINES, IF THE STANDARDS AND SPECIFICATIONS ARE NOT CONTAINED IN THE APPROVED ESCP.
- 5. THE CONTRACTOR SHALL BE RESPONSIBLE FOR IMPLEMENTATION, MONITORING AND MANAGEMENT OF ALL EROSION AND SEDIMENT CONTROL MEASURES TO THE SATISFACTION OF DEPWS.
- 6. THE CONTRACTOR SHALL TAKE ALL REASONABLE AND PRACTICABLE MEASURES TO CONTROL STORM WATER FLOW VELOCITIES, MINIMISE SOIL EROSION AND SEDIMENT RUNOFF, AND MITIGATE ENVIRONMENTAL HARM.
- 7. UNEXPECTED CIRCUMSTANCES OR LARGE STORM EVENTS MAY NECESSITATE AMENDMENT OF THE ESCP. IN THE EVENT THAT SITE CONDITIONS CHANGE SIGNIFICANTLY FROM THOSE CONSIDERED WITHIN THE APPROVED ESCP, A REVISED EROSION AND SEDIMENT CONTROL PLAN (ESCP) SHALL BE SUBMITTED FOR APPROVAL TO DEPWS AND ADDITIONAL EROSION AND SEDIMENT CONTROL MEASURES SHALL BE IMPLEMENTED.
- 8. WHERE THERE IS HIGH PROBABILITY OF ENVIRONMENTAL HARM OCCURRING DUE TO SEDIMENT LEAVING THE SITE, CONTRACTOR SHALL IMPLEMENT ALL REASONABLE AND PRACTICABLE MEASURES REQUIRED TO MITIGATE SUCH HARM, INCLUDING IMPLEMENTATION OF APPROPRIATE ADDITIONAL CONTROL MEASURES, WITH THE ESCP AMENDED AS SOON AS POSSIBLE AND RE-SUBMITTED FOR APPROVAL TO DEPWS.
- 9. THE CONTRACTOR SHALL MAINTAIN SUFFICIENT EROSION AND SEDIMENT CONTROL MATERIALS ON SITE FOR SHORT NOTICE REPAIRS.
- 10. THE CONTRACTOR SHALL MONITOR THE WORKS AREA WEEKLY, OR DAILY DURING RAINFALL, AND ADAPT ESC PRACTICES AS REQUIRED TO MAINTAIN THE REQUIRED PERFORMANCE STANDARD.

SITE	SEC 5720 HUNDRED OF BAGOT
ADDRESS	740 BERRIMAH ROAD EAST ARM, NT
DEVELOPMENT PERMIT	PA2021/0364
AREA OF WORKS	Арргох. 9ha
CONSTRUCTION PERIOD	OCT 2023 - APR 2024 (SEE NOTE 2)
CONTRACTOR CONTACTS	
SITE MANAGER	TODD DOW 0488 399 297
SITE MANAGER	KIM BEARDSELL 0427 542 434
<ul> <li>PROJECT MANAGER</li> </ul>	LEIGH FITZPATRICK 0498 784 573
ENVIRONMENTAL OFFICER	CHRISTIAN CLEARY 0419 549 676
ESCP DESIGNER	ETHAN DILETTOSO 0474 296 911
	CPESC No. 00009816

CHECKED JCM		BULK FUEL STORAGET SEASON ESCP	GE FACILITY			
CHECKED ED	SCALE PROJECT Nº DRAWING Nº ESC100					

SITE MANAGEMENT 1. CONSTRUCTION ACTIVITIES SHALL BE STAGED SO THAT LAND DISTURBANCE IS CONFINED TO AREAS OF MANAGEABLE SIZE AND THE	SURFACE WATER AND DRAINAGE CONTROL 1. ALL DRAINAGE CONTROL MEASURES SHALL BE APPLIED AND MAINTAINED IN ACCORDANCE WITH APPROVED ESCP DRAWINGS.	SEDIMENT CONTROL 1. ALL SEDIMENT CONTROL MEASUR
EXTENT AND DURATION OF SOIL EXPOSURE IS LIMITED. EROSION AND SEDIMENT CONTROL MEASURES SHALL BE PROGRESSIVELY IMPLEMENTED TO SUIT.	2. DURING THE CONSTRUCTION PHASE, ALL REASONABLE AND PRACTICABLE MEASURES SHALL BE IMPLEMENTED TO:	2. ALL REASONABLE AND PRACTIC SEDIMENT FROM THE SITE. SEDIM
2. ALL OFFICE AND OPERATIONAL ACTIVITIES SHALL BE LOCATED SUCH THAT ALL LIQUID EFFLUENT (E.G. WASH-DOWN WATER) IS	A.DIVERT CLEAN SURFACE WATERS AWAY FROM THE SITE IN A MANNER THAT MINIMISES EROSION OR CONTAMINATION OF WATER.	PRACTICABLE.
TOTALLY CONTAINED AND TREATED WITHIN THE SITE. 3. ALL LIQUIDS AND CHEMICALS SHALL BE STORED AND HANDLED ON-SITE IN ACCORDANCE WITH RELEVANT STANDARDS, INCLUDING	B.CONTROL FLOW VELOCITIES AND PREVENT SOIL EROSION ALONG DRAINAGE PATHS, INCLUDING ENTRY/EXIT POINTS; AND ENSURE ALL WATERS ARE DISCHARGED ONTO STABLE LAND, IN A NON-EROSIVE MANNER, AND AT A LEGAL POINT OF DISCHARGE.	3. SEDIMENT CONTROL DEVICES SH
AS1940 - THE STORAGE AND HANDLING OF FLAMMABLE AND COMBUSTIBLE LIQUIDS.	C.MANAGEMENT OF DRAINAGE IS TO AVOID CONCENTRATION OF FLOW.	<ol> <li>SEDIMENT FENCES SHALL BE INS DRAWINGS SF-01 AND SF-02. EN</li> </ol>
4. SITE SPOILS SHALL BE LAWFULLY DISPOSED OF IN A MANNER THAT DOES NOT RESULT IN ONGOING SOIL EROSION OR ENVIRONMENTAL HARM.	D.OPEN PROFILE TRAPEZOIDAL DRAINS INSTEAD OF "V" DRAINS ARE TO BE USED.	5. SEDIMENT CONTROLS SHALL REI
5. EXCAVATION WORKS SHALL BE STAGED SO THAT THE DURATION OF EXPOSED OPEN TRENCHES IS LIMITED. TRENCHING SHALL ONLY BE	<ol> <li>CONTROL WATER MOVEMENT THROUGH THE WORKS AREA; FLOW DIVERSION BANKS AND CATCH DRAINS SHALL BE INSTALLED AS PER DRAWINGS.</li> </ol>	6. TRACKING OF SEDIMENTS ONTO F TO DEFINED POINTS, WITH SUPPI
OPENED UP WHERE IT IS INTENDED TO BE BACKFILLED IN THE SAME WORKING DAY.	EROSION CONTROL AND SURFACE STABILISATION	7. SEDIMENT CONTROL DEVICES SH
6. NO LIQUID EFFLUENT IS PERMITTED TO BE DISPOSED OF ON SITE.	1. ALL EROSION CONTROL MEASURES SHALL BE APPLIED AND MAINTAINED IN ACCORDANCE WITH APPROVED ESCP DRAWINGS.	8. SEDIMENT CONTROLS SHALL BE
<ol> <li>ACCESS TRACKS SHALL BE GRADED TO A CROWN OR WITH CROSSFALL DRAINAGE.</li> <li>ACCESS TRACKS SHALL INCORPORATE STABILISED ENTRY/EXIT POINTS.</li> </ol>	<ol><li>SYNTHETIC EROSION CONTROL TREATMENTS SHALL NOT BE USED IF SUCH MATERIALS ARE LIKELY TO CAUSE ENVIRONMENTAL HARM.</li></ol>	INSTALLATION AND MAIN
<ol> <li>ACCESS TRACKS SHALL INCOMPORATE STADILISED ENTITIENT FOUNTS.</li> <li>ACCESS TRACKS SHALL BE MONITORED FOR EXCESSIVE SEDIMENT TRACKING INTO ADJACENT PUBLIC ROADS. A REVIEW OF THE CONTROLS SHALL BE UNDERTAKEN BY THE CONTRACTOR AND ADDITIONAL MEASURES MAY BE EMPLOYED WHERE SEDIMENT BUILD-UP OCCURS ON PUBLIC ROADS AT VEHICLE EXIT POINTS.</li> </ol>	DEWATERING 1. THE CONTRACTOR SHALL MITIGATE SEDIMENT RELATED ENVIRONMENTAL HARM AND/OR IMPACT TO STORMWATER INFRASTRUCTURE RESULTING FROM DEWATERING ACTIVITIES.	1. THE INSTALLATION AND MAINTE QUALIFIED PERSON (E.G. CERTIFIE CONSISTENT WITH THE APPROVI
CLEARING AND GRUBBING	2. FLOW DIVERSION BARRIERS, OR OTHER APPROPRIATE SYSTEMS, SHALL BE USED TO MINIMISE THE QUANTITY OF WATER ENTERING	2. THE CONTRACTOR SHALL ENSUR MONITORING AND MAINTENANCE
1. MINIMISE DISTURBANCE TO ONLY THOSE AREAS REQUIRED FOR CONSTRUCTION. ALL OTHER AREAS SHALL BE FLAGGED AS "NO-GO ZONE"		3. DRAINAGE CONTROLS SHALL BE
2. ALL CLEARING SHALL BE CONDUCTED IN ACCORDANCE WITH FEDERAL, TERRITORY AND LOCAL GOVERNMENT ENVIRONMENTAL POLICIES.	<ol> <li>DEWATERING CONTROL MAY INCLUDE GEOFABRIC FILTERS AND NON-WOVEN FILTER FENCING.</li> <li>SEDIMENT LADEN WATER SHALL NOT BE DISCHARGED OFF-SITE WITHOUT FIRST BEING TREATED SATISFACTORILY TO THE</li> </ol>	4. SEDIMENT CONTROLS, SHALL BE
3. BEFORE CLEARING COMMENCES, AREAS OF VEGETATION NOMINATED FOR PROTECTION SHALL BE CLEARLY IDENTIFIED AND MARKED ON	FOLLOWING REQUIREMENTS:	MATERIALS, WHETHER LIQUID O SHALL BE DISPOSED OF IN AN A
SITE (BY FLAGGING OR FENCING) BY THE CONTRACTOR AND INSPECTED BY THE SUPERINTENDENT. CLEARING OF VEGETATION SHALL BE RESTRICTED TO THE NOMINATED AREAS. CONTRACTOR SHALL TAKE ALL REASONABLE AND PRACTICABLE MEASURES TO MITIGATE	– TURBIDITY: MAX 75 NTU – PH: 6.5 TO 8.5	MATERIALS SHALL BE DISPOSED PRACTICABLE, CAPTURED SEDIM
RISK OF UNNECESSARY LAND CLEARING AND PREVENT REMOVAL OR DISTURBANCE OF ALL VEGETATION AND GROUND COVERS	REVEGETATION AND REHABILITATION	5. IF ANY EROSION AND SEDIMENT
	<ol> <li>ALL DISTURBED AREAS AND EARTHWORKS SHALL BE PROGRESSIVELY REHABILITATED WITH GRASS, OR OTHER COVER. REFER PROJECT DRAWINGS FOR LANDSCAPING DETAILS.</li> </ol>	LOSS, THE CONTRACTOR SHALL IMPROVEMENTS, SUBSTITUTES,
4. WHERE CLEARING IS REQUIRED FOR THE PURPOSE OF INSTALLING EROSION AND SEDIMENT CONTROL MEASURES, EXTENTS OF CLEARING SHALL BE KEPT TO A MINIMUM.	2. DUE TO WORKS BEING UNDERTAKEN DURING THE WET SEASON, GRASSING SHALL BE APPLIED VIA HYDROMULCHING.	6. ALL TEMPORARY EROSION AND
5. DISTURBANCE OF THE NATURAL ENVIRONMENT SHALL BE LIMITED TO THE MINIMUM IN KEEPING WITH THE SITE CLEARING PLANS.	TRENCHING	STABILISATION OF WORKS ARE
6. THE CONTRACTOR SHALL TAKE ALL PRACTICABLE AND REASONABLE MEASURES DURING CLEARING OPERATIONS TO PREVENT THE FORMATION OF FLOW PATHS THAT CAN CONCENTRATE SURFACE RUNOFF AND CREATE POTENTIAL FOR EROSION.	1. TRENCHES SHALL BE EXCAVATED, LAID AND BACKFILLED WITHIN THE SAME DAY TO REDUCE EXPOSURE.	7. THE CONTRACTOR SHALL MAINT ANY REQUIRED REPAIRS IN TIME
STOCKPILE MANAGEMENT	2. EXCAVATED TRENCH MATERIAL SHALL BE USED TO CREATE FLOW CONTROL BERMS ON THE UPSTREAM SIDE OF THE TRENCH.	
1. THE CONTRACTOR SHALL AVOID PLACEMENT OF STOCKPILES (WHERE PRACTICABLE) WITHIN 50m OF ANY DRAINS, DRAINAGE LINE OR OTHER WATERWAYS. SUITABLE TYPE 2/3 EROSION AND SEDIMENTATION CONTROLS TO BE IMPLEMENTED WHERE NOT PRACTICABLE.	ROCK FILTER DAMS (WITH FILTER CLOTH) 1. HEIGHT OF ROCK FILTER DAM (H) TO BE 500mm IN ALL CASES.	MONITORING AND REPOR 1. ALL EROSION AND SEDIMENT CO
2. THE FOLLOWING CONTROLS SHALL BE IMPLEMENTED FOR STOCKPILES OF ERODIBLE MATERIAL:	<ol> <li>WHERE RFD IS LOCATED IN DRAINAGE CHANNELS, THE CONTRACTOR SHALL EXTEND ROCK UP BATTERS TO FORM A 200mm SPILLWAY CHUTE (FREEBOARD FROM SHOULD/TOP OF BATTER).</li> </ol>	A. ROUTINE WEEKLY INSPECTIO
A. STOCKPILES SHALL BE LOCATED AT LEAST 2m FROM ANY RETAINED VEGETATION AND CONCENTRATED DRAINAGE LINES.	3. WHERE RFD IS LOCATED IN DRAINAGE CHANNELS, IT MAY BE REQUIRED TO SHIFT THEM UPSTREAM FROM THE END OF DRAIN TO	B. MONTHLY DETAILED ADUITS
B. EARTH DIVERSION BUNDS SHALL BE INSTALLED IMMEDIATELY UP-SLOPE OF THE STOCKPILE, WHERE THE CONTRIBUTING CATCHMENT EXCEEDS 1500m2 AND SHALL BE MANAGED TO AVOID CONCENTRATING FLOW CAUSING EROSION.	ENSURE THE DRAIN HAS SUFFICIENT DEPTH FOR INSTALLATION OF CONTROLS WITH CONTROLLED OVERFLOW SPILLWAYS. WHERE IT IS NOT PRACTICABLE TO ACHIEVE A DRAIN HEIGHT OF 700mm, RFD HEIGHT (H) SHOULD BE REDUCED AND THE 200mm SPILLWAY	C. DAILY, WHEN RAIN IS OCCUR DURATION TO CAUSE ON-SI
C. SEDIMENT CONTROL MEASURES SHALL BE INSTALLED DOWNSTREAM OF THE STOCKPILE (E.G. MULCH BERMS OR SEDIMENT FENCES).	DEPTH SHOULD BE MAINTAINED.	D. WITHIN 24 HOURS PRIOR TO
D. TRENCH SPOIL AND BACKFILL MATERIAL SHALL GENERALLY BE STOCKPILED A MINIMUM OF 1.0m FROM OPEN TRENCHES.		2. ALL SEDIMENT DEPOSITED OFFS
3. STOCKPILE OF MATERIALS VULNERABLE TO SEDIMENTATION SHALL COVERED IF REQUIRED.		APPROPRIATELY CLEANED / RE 3. ANY FAILURE IN APPLIED DRAIN
4. STRIPPED TOPSOIL SHALL BE STOCKPILED FOR REUSE. TOPSOIL STOCKPILE HEIGHTS SHALL BE 1.5m MAX. ALL OTHER STOCKPILE HEIGHTS SHALL BE 3.0m MAX WITH 1 IN 4 BATTERS MAX.		AND SENIOR ENVIRONMENTAL A
5. TOPSOIL STOCKPILES SHALL NOT BE COMPACTED OR WHEEL ROLLED.		4. ANY INCIDENT WHICH RESULTS I HAS POTENTIAL TO RESULT IN S
6. LONG-TERM STOCKPILES (10 DAYS OR MORE) SHALL BE ADEQUATELY STABILISED (E.G. COVER, VEGETATION, SOIL BINDER, OR OTHER) AS DEEMED APPROPRIATE BY THE ESCP DESIGNER.		AUTHORITY (NTEPA) WITHIN 24
7. ALL DISTURBED AREAS OF STOCKPILES SHALL BE SUITABLY STABILISED AND REHABILITATED WITH GRASS OR OTHER COVER.		
DUST CONTROL 1. ALL DUST CONTROL MEASURES SHALL BE APPLIED AND MAINTAINED IN ACCORDANCE WITH APPROVED ESCP DRAWINGS.		
2. THE CONTRACTOR SHALL BE RESPONSIBLE FOR THE EFFECTIVE CONTROL OF ALL DUST AND WINDBORNE MATERIAL EMANATING FROM THE SITE THROUGHOUT THE CONSTRUCTION PERIOD.		
3. THE CONTRACTOR SHALL IMPLEMENT ALL MEASURES NECESSARY TO MINIMISE WIND EROSION AND PREVENT MATERIAL FROM THE SITE BEING BLOWN OVER OR ONTO PROPERTY OUTSIDE OF THE SITE. MEASURES SHALL INCLUDE BUT NOT BE LIMITED TO:		
A.MINIMISING TRAFFIC MOVEMENTS ON DISTURBED SURFACES AND LIMITING VEHICLE SPEEDS TO 25KPH;		
B.MAINTAINING EXPOSED SURFACES IN A MOIST CONDITION THROUGH FREQUENT WATERING;		
C.PROGRAMMING WORKS TO MINIMISE THE LIFE OF SOIL STOCKPILES, OR TEMPORARILY STABILISING LONG TERM STOCKPILES.		
4. DURING DRY PERIODS, UTILISE WATER TRUCK TO WATER DOWN WORKS SURFACES TO MINIMISE DUST GENERATION. DUST SUPPRESSION SHALL BE IMPLEMENTED BY SITE SUPERVISOR AS REQUIRED BY VISUAL INSPECTION.		

No	DATE	INITIAL	AMENDMENT				PI		
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ONTROL MEASURES SHALL BE APPLIED AND MAINTAINED IN ACCORDANCE WITH APPROVED ESCP DRAWINGS.

LE AND PRACTICABLE MEASURES SHALL BE TAKEN TO PREVENT, OR AT LEAST MINIMISE, THE RELEASE OF 1 THE SITE. SEDIMENT CONTROL DEVICES SHALL BE INSTALLED TO TRAP SEDIMENT AS CLOSE TO THE SOURCE AS

ROL DEVICES SHALL NOT PRESENT A SAFETY HAZARD FOR SITE WORKERS AND/OR THE PUBLIC.

ES SHALL BE INSTALLED ALONG THE DOWN SLOPE SIDE OF THE EARTHWORK ACTIVITIES AS PER IECA STANDARD 1 AND SF-02. ENSURE RETURNS ARE PROVIDED.

ROLS SHALL REMAIN IN PLACE UNTIL THE ACTIVITIES ARE FINISHED AND AREAS ARE STABILISED.

DIMENTS ONTO ROADS EXTERNAL OF THE SITE IS NOT PERMITTED. ENTRY/EXIT TO SITE SHALL BE RESTRICTED NTS. WITH SUPPLEMENTARY ENTRY/EXIT SEDIMENT CONTROLS INSTALLED.

ROL DEVICES SHALL BE DE-SILTED WHEN CAPACITY IS REDUCED BELOW 75%.

ROLS SHALL BE INSPECTED WEEKLY DURING CONSTRUCTION AND IMMEDIATELY AFTER EACH RAINFALL EVENT. N AND MAINTENANCE

#### ION AND MAINTENANCE OF ALL EROSION AND SEDIMENT CONTROLS SHALL BE OVERSEEN BY A SUITABLY SON (E.G. CERTIFIED PROFESSIONAL IN EROSION AND SEDIMENT CONTROL) TO ENSURE WORK PRACTICES ARE TH THE APPROVED ESCP.

OR SHALL ENSURE SUITABLE CONSTRUCTION ACCESS IS AVAILABLE FOR THE INSTALLATION AND ONGOING MAINTENANCE OF SEDIMENT CONTROL DEVICES.

ROLS SHALL BE MAINTAINED TO PREVENT BLOCKAGES AND UNCONTROLLED WATER DIVERSION/ FLOODING.

ROLS, SHALL BE MAINTAINED TO ENSURE SEDIMENT RETENTION CAPACITY DOES NOT FALL BELOW 75%. ALL ETHER LIQUID OR SOLID, REMOVED FROM SEDIMENT CONTROL DEVICES AND PLACES OF SEDIMENT DEPOSITION, SED OF IN AN APPROVED MANNER THAT DOES NOT CAUSE FURTHER SOIL EROSION OR ENVIRONMENTAL HARM. ALL BE DISPOSED OF IN A LOCATION THAT PREVENTS MATERIALS RE-ENTERING THE SYSTEM. WHERE CAPTURED SEDIMENT SHALL BE MIXED INTO EARTHWORKS OPERATIONS.

AND SEDIMENT CONTROLS ARE FOUND TO BE DAMAGED OR INEFFECTIVE, RESULTING IN EROSION OR SEDIMENT TRACTOR SHALL MAKE GOOD AND CONSULT THE ESCP DESIGNER TO IDENTIFY NEEDS FOR ADDITIONAL REPAIRS, , SUBSTITUTES, OR ADDITIONAL CONTROL MEASURES.

FROSION AND SEDIMENT CONTROLS SHALL BE MAINTAINED FULLY OPERATIONAL UNTIL PERMANENT OF WORKS AREAS IS COMPLETED (MIN, 80% GRASS COVERAGE).

OR SHALL MAINTAIN SUFFICIENT SPARE MATERIALS (E.G. GEOFABRIC, SEDIMENT FENCE, MULCH, ROCK) TO ENABLE REPAIRS IN TIMELY MANNER.

## ND REPORTING

ND SEDIMENT CONTROL MEASURES SHALL BE INSPECTED:

EKLY INSPECTIONS, WHEN WORKS ARE BEING UNDERTAKEN ONSITE;

RAIN IS OCCURING, AND WITHIN 18 HOURS FOLLOWING A RAINFALL EVENT OF SUFFICIENT INTENSITY AND O CAUSE ON-SITE RUNOFF; AND

OURS PRIOR TO EXPECTED RAINFALL.

DEPOSITED OFFSITE AS A DIRECT RESULT OF CONSTRUCTION ACTIVITIES SHALL BE REMOVED AND THE AREA CLEANED / REHABILITATED AS SOON AS PRACTICABLE.


APPLIED DRAINAGE, EROSION AND SEDIMENT CONTROLS SHALL BE REPORTED TO THE CONSTRUCTION MANAGER VIRONMENTAL ADVISOR WITHIN 24 HOURS OF THE INCIDENT OCCURRING.

HICH RESULTS IN UNAUTHORISED DISCHARGE OF SEDIMENT OR SEDIMENT LADEN WATER TO A WATERWAY, OR TO RESULT IN SERIOUS ENVIRONMENTAL HARM, SHALL BE REPORTED TO THE NT ENVIRONMENT PROTECTION EPA) WITHIN 24 HOURS VIA THE POLLUTION HOTLINE ON 1800 064 567.

# **ISSUED FOR CONSTRUCTION**

WARNING
BEWARE OF UNDERGROUND SERVICES
The locations of underground services are approximate only
and their exact position should be proven on site
No guarantee is given that all existing services are shown

CHECKED		<b>JLK FUEL STORAG</b> T SEASON ESCP	SE FACILITY	
CHECKED	SCALE	PROJECT № <b>NT23046</b>	DRAWING No ESC101	

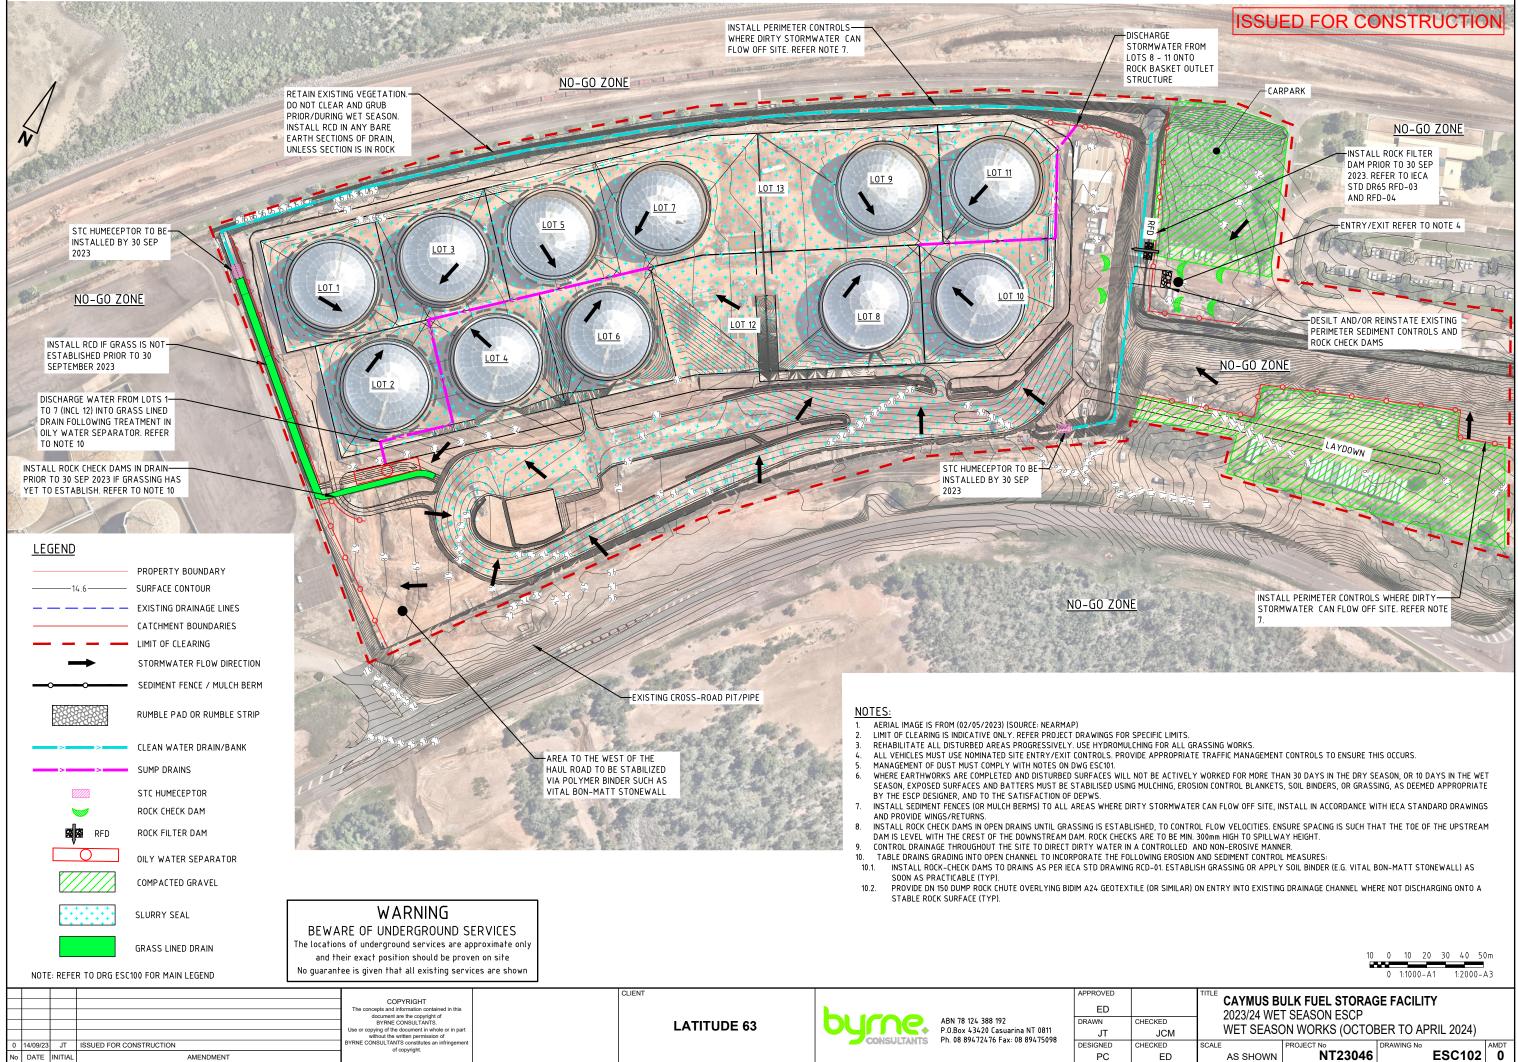


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KED JCM	2023/24 WE	<b>JLK FUEL STORAG</b> T SEASON ESCP DN WORKS (OCTOE			
KED ED	SCALE AS SHOWN	PROJECT № <b>NT23046</b>	DRAWING No	ESC102	AMDT <b>0</b>

# **ISSUED FOR CONSTRUCTION**

14/09/23 JT ISSUED FOR CONSTRUCTION

No DATE INITIAL

AMENDMENT

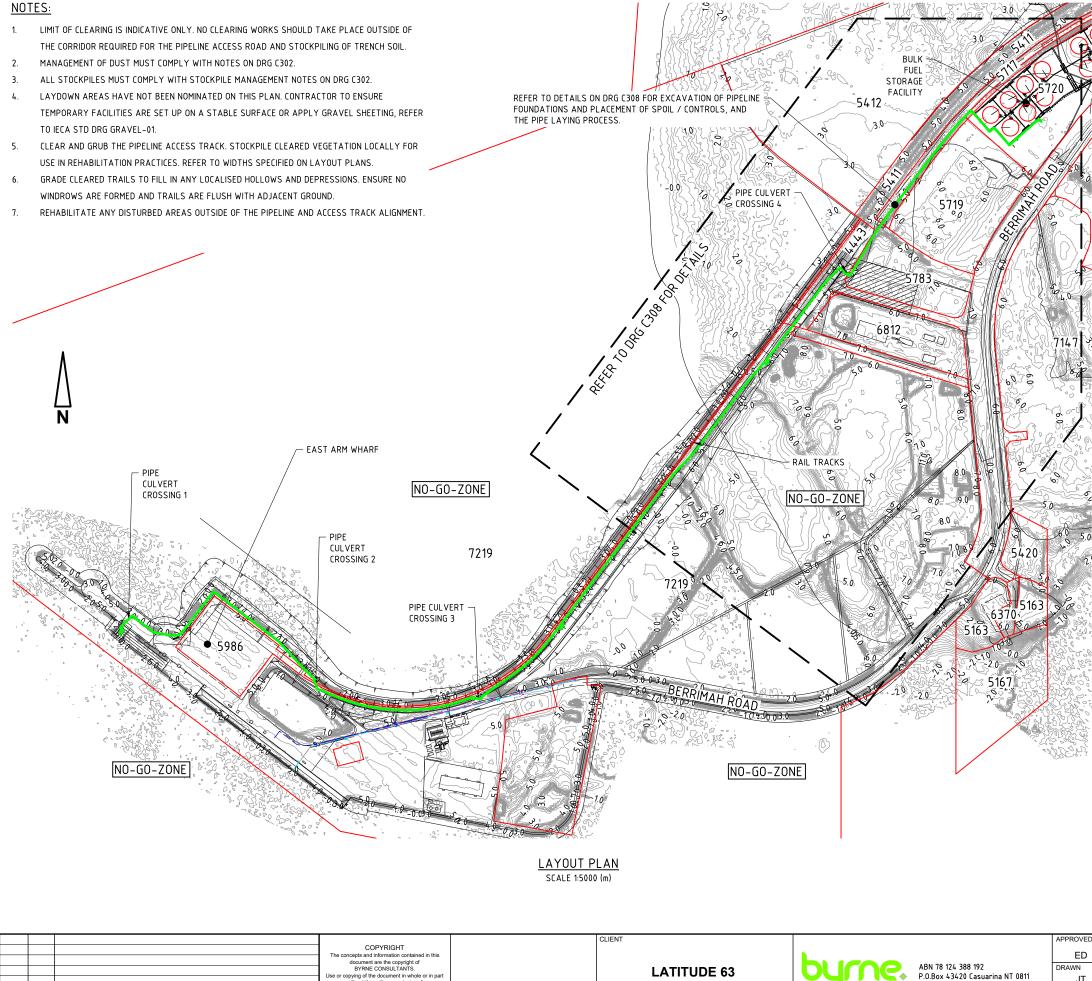


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## **LEGEND**

PROPERTY BOUNDARY

FUEL PIPELINE ALIGNMENT



CHECKED	SCALE	PROJECT No	DRAWING No	AMDT
ED	AS SHOWN	NT23046	ESC200	0

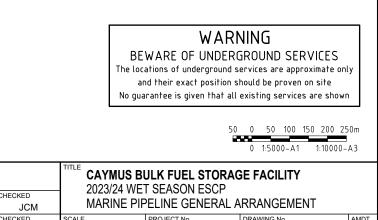
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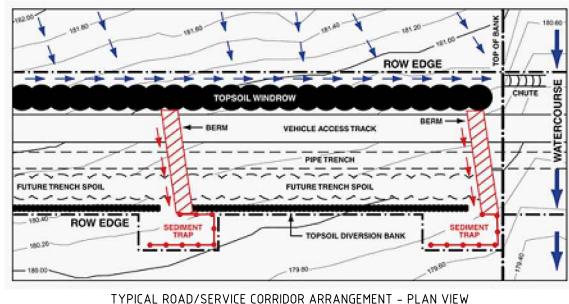
DESIGNED

Ph. 08 89472476 Fax: 08 89475098


CONSULTANTS




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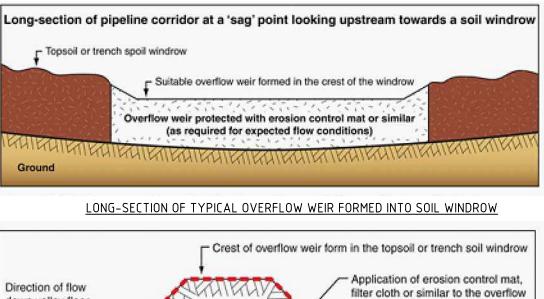


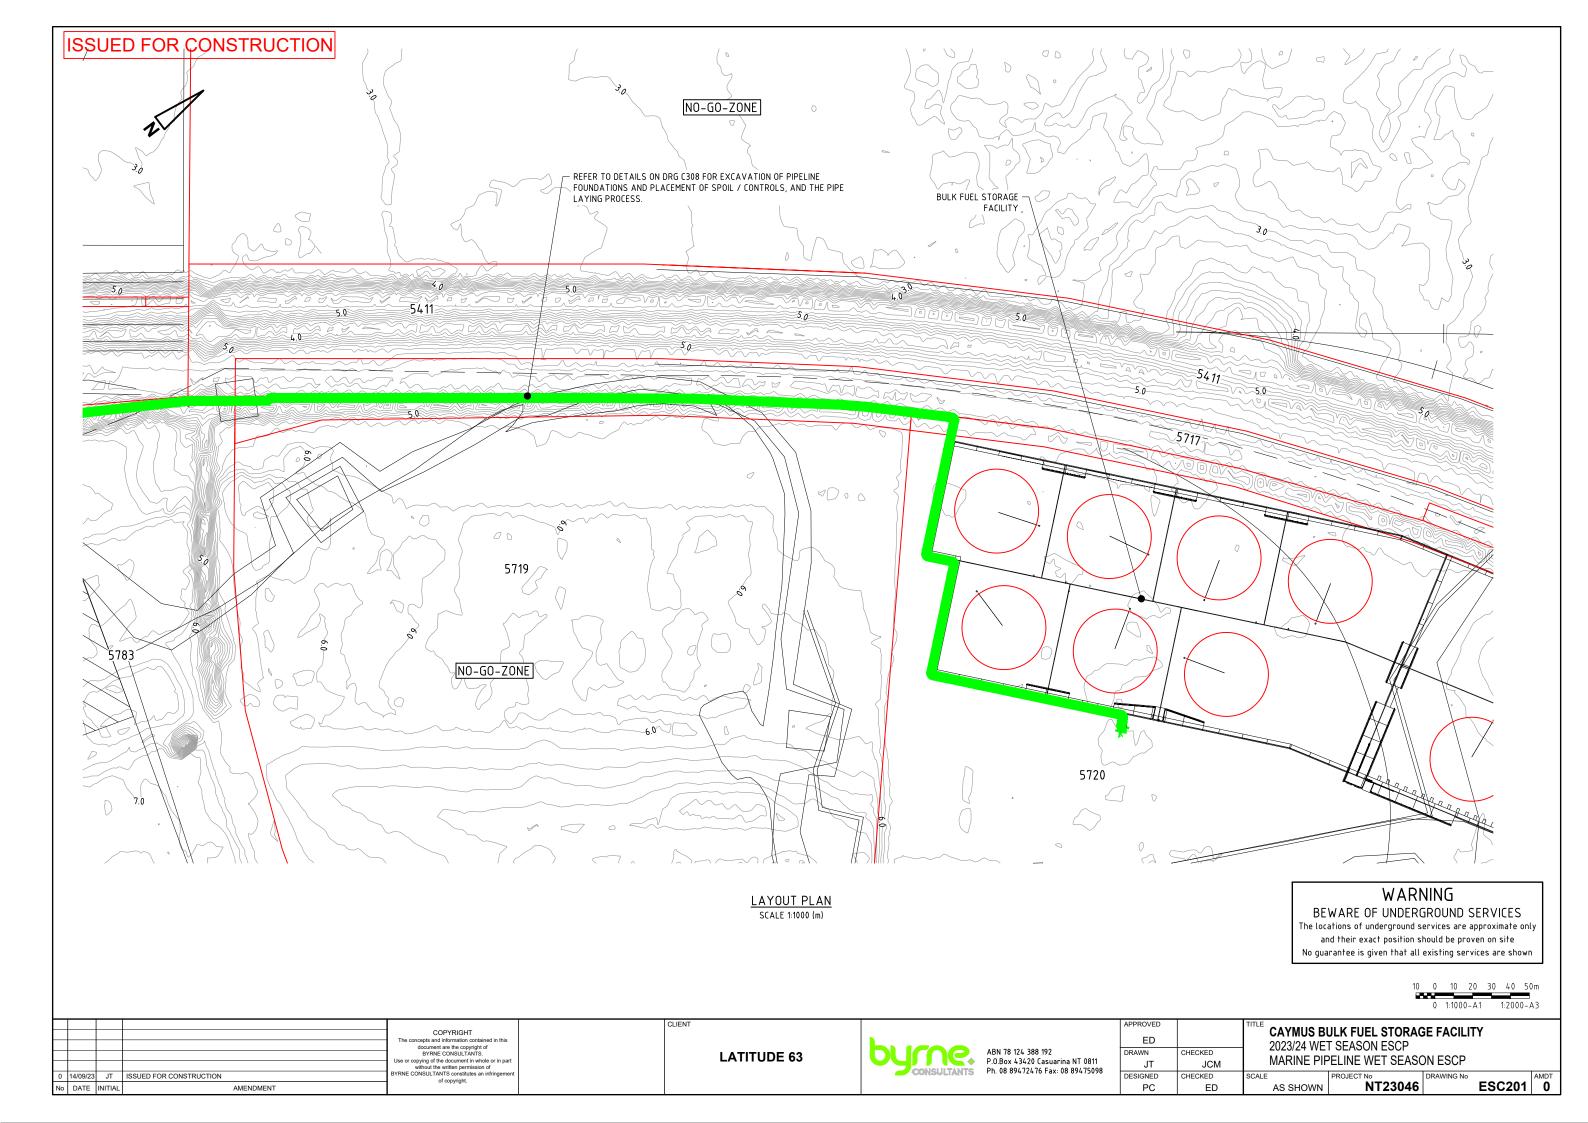
REFER TO DIVERSION BANK DETAILS

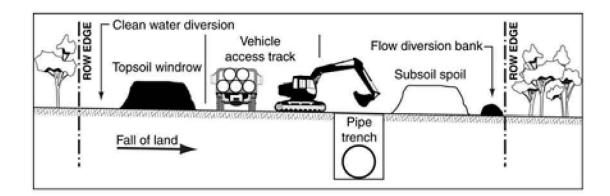

## TYPICAL ROAD/SERVICE CORRIDOR ARRANGEMENT - SECTION VIEW PIPE IS ABOVEGROUND - EXCAVATION ONLY REQUIRED FOR PIPE RACK FOOTINGS / FOUNDATIONS



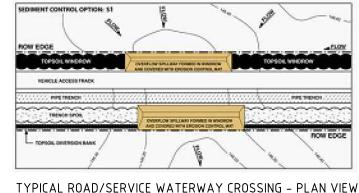

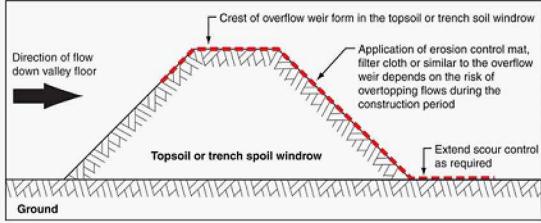

CROSS-SECTION OF TYPICAL OVERFLOW WEIR FORMED INTO SOIL WINDROW

## NOTE:

- THE DETAILS PRESENTED IN THIS SHEET ARE EXTRACTS FROM IECA APPENDIX P PIPELINES (2015). THEY PRESENT STANDARD ARRANGEMENTS FOR WATER MAIN AND/OR SERVICES INSTALLATION WORKS CONSIDERED LOW RISK AND TO BE COMPLETED DURING THE DRY SEASON VARIATION TO THE STANDARD ARRANGEMENT FOR DRAINAGE LINES AND WATERWAY CROSSINGS MAY BE ACCEPTED IF IN ACCORDANCE WITH ALTERNATIVE ARRANGEMENTS PRESENTED WITHIN APPENDIX P AND COMPLETION OF RISK ASSESSMENT BY CONTRACTOR. CROSSING OF DRAINAGE LINES AND WATERWAYS SHOULD OCCUR DURING PERIODS OF NO FLOW OR FORECAST RAINFALL. BASED ON RISK 1. 2.
- 3. ASSESSMENT IN SUCH INSTANCES, INSTALLATION OF OVERFLOW SPILLWAY WITHIN DRAINAGE LINE MAY BE AVOIDED IF WORKS CAN BE COMPLETED, INCLUDING REINSTATEMENT OF DRAINAGE LINE CROSSING TO A NON-EROSIVE PROFILE PRIOR TO FLOW OCCURING.
- DISTURBANCE TO CROSSINGS SHOULD NOT OCCUR UNTIL IMMEDIATELY PRIOR TO TRENCHING, BACKFILL AND REINSTATEMENT OF DRAINAGE LINE 4 CROSSINGS TO A NON-EROSIVE PROFILE SHOULD BE COMPLETED RAPIDLY FOLLOWING SERVICE INSTALLATION.
- PIPE TO BE ABOVEGROUND. EXCAVATION ONLY REQUIREMENT FOR PIPE RACK FOOTINGS/FOUNDATIONS. 5.

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